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NESPA ENTERPRISES INC.

2800 Richter Ave. Ste. C Oroville, CA 95966 Office: (530) 534-9910 Fax: (530) 534-9915

E-Mail:sales@tiledspas.com Web Site:www.tiledspas.com

W	SIZE	DWG TYPE
NESPA	SCALE	1/2" = 1'

A PLUMBING 2

DATE 4/13/2007

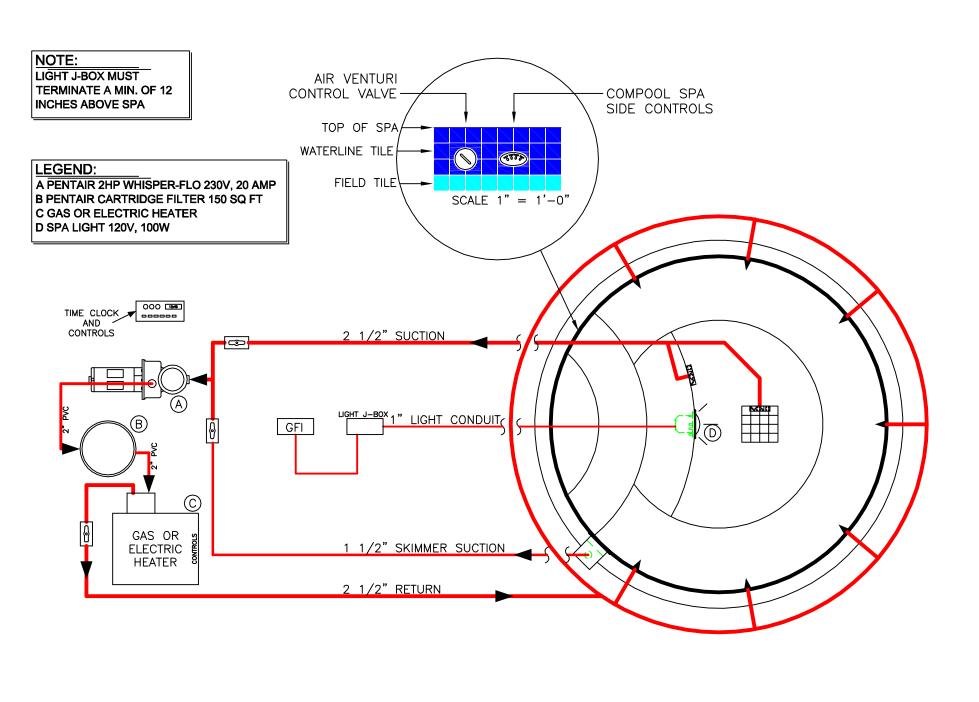
DWG NO.
PLUMBING

SHEET

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NESPA

SIZE A DWG TYPE PLUMBING 3

DWG NO.
PLUMBING

SHEET

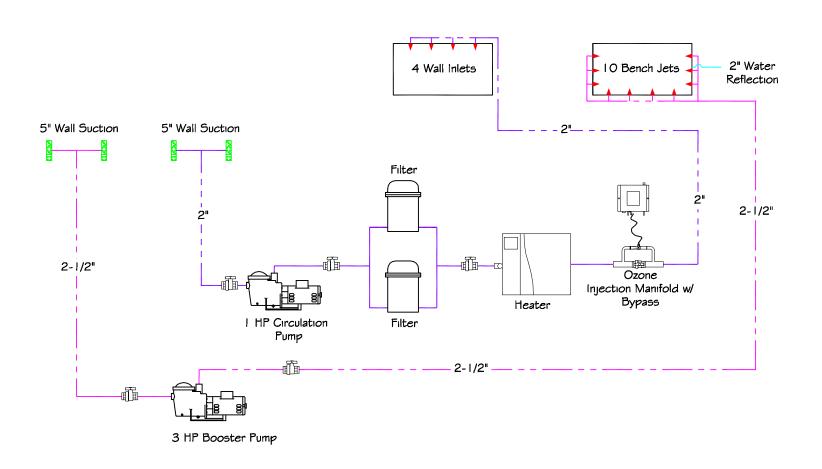
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E-Mail:sales@tiledspas.com Web Site:www.tiledspas.com NESPA SCALI

SCALE 1/2" = 1'

DATE 4/13/2007

PAGE 1 OF 1

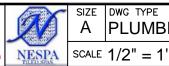


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A PLUMBING SCHEMATIC

DATE 6/11/2007

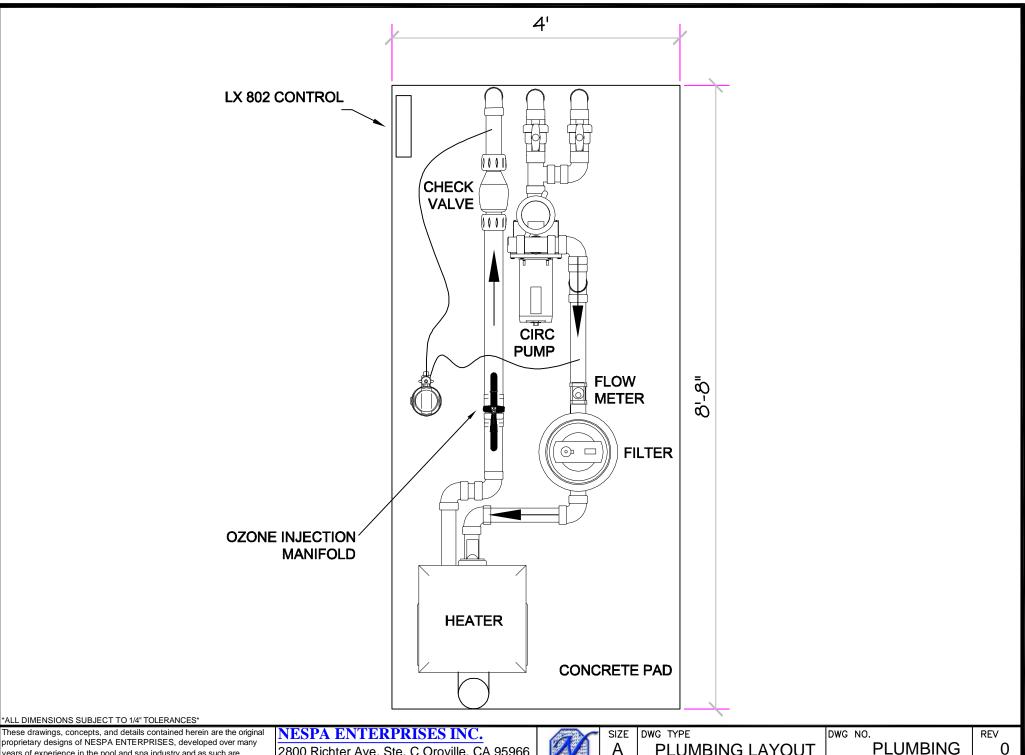
DWG NO.
PLUMBING

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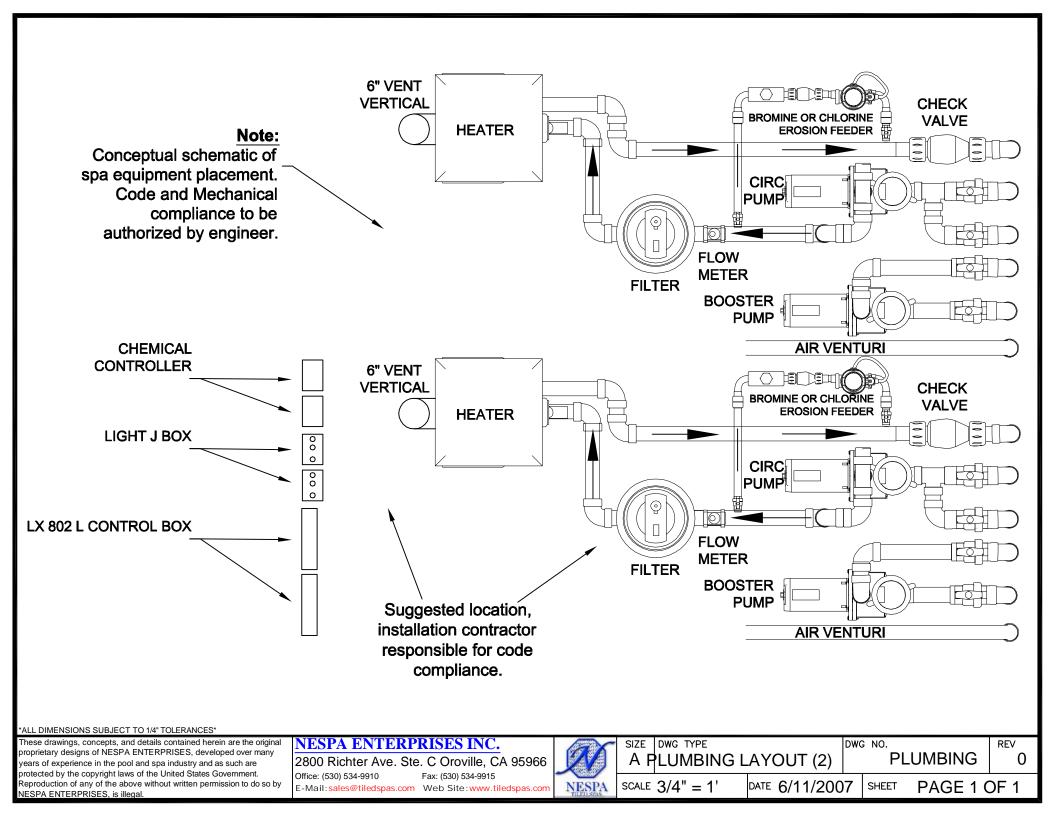


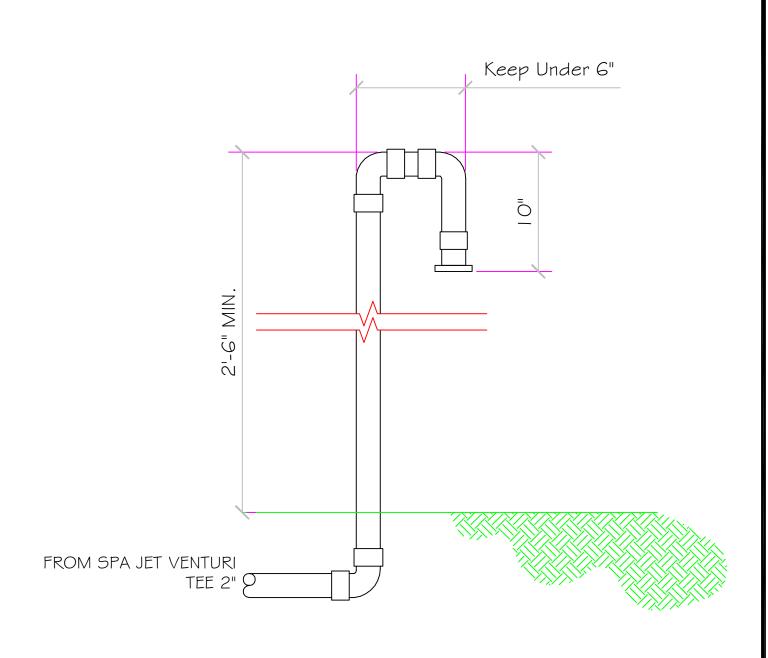
PLUMBING LAYOUT

DATE 6/11/2007

**PLUMBING** 

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## AIR SUPPLY LOOP DETAIL

ALL DIMENSIONS SUBJECT TO 1/4" TOLERANCES\*

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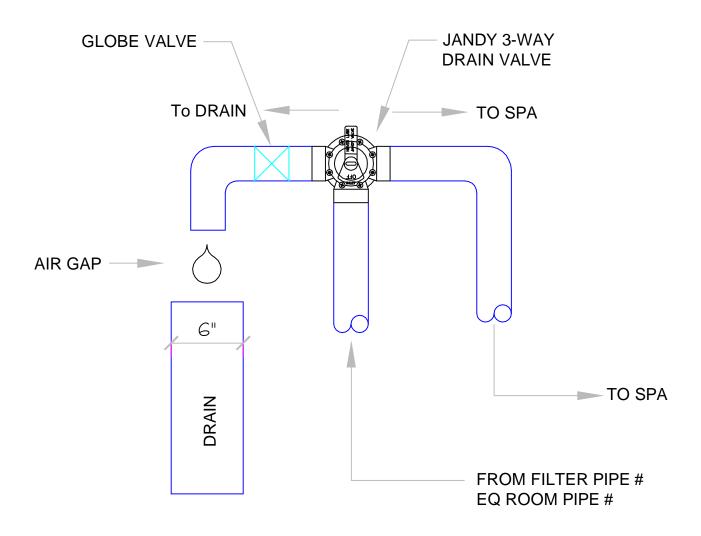
A AIR SUPPLY DETAIL

DWG NO.
PLUMBING DETAILS

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SCALE  $1 \frac{1}{2} = 1'$  DATE  $\frac{4}{9} = 2007$ 

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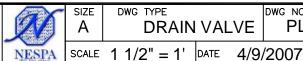


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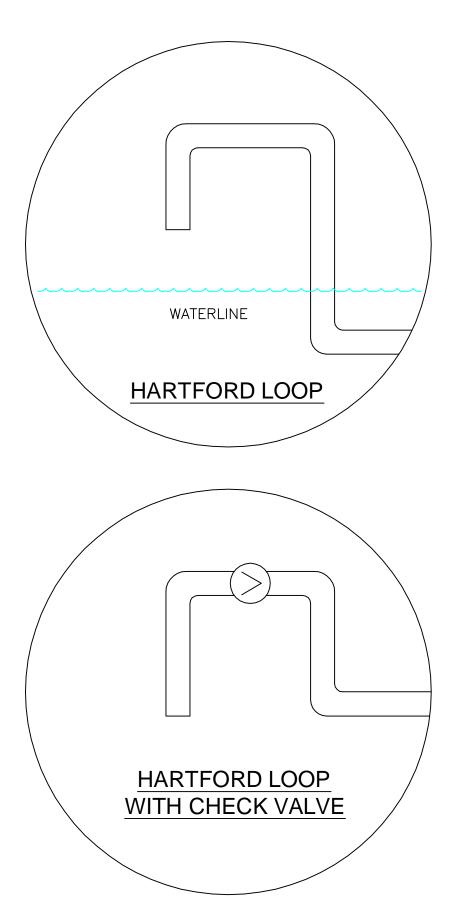
DWG TYPE SIZE DRAIN VALVE

DWG NO. PLUMBING DETAILS

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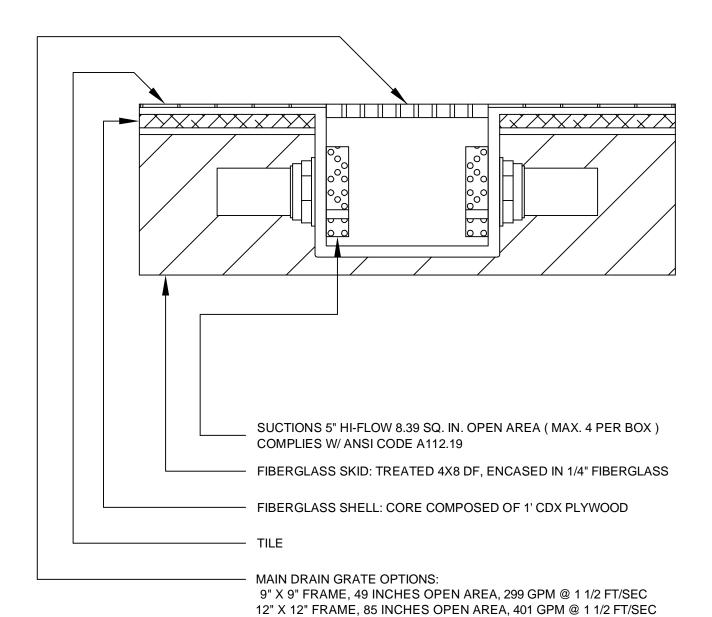
A HARTFORD LOOP

DWG NO.
PLUMBING DETAILS

S REV

SCALE N/A DATE 4/9/2007 SHEET PAGE 1 OF 1

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SIZE DWG TYPE MAIN DRAIN DWG NO. PLUMBING DETAILS

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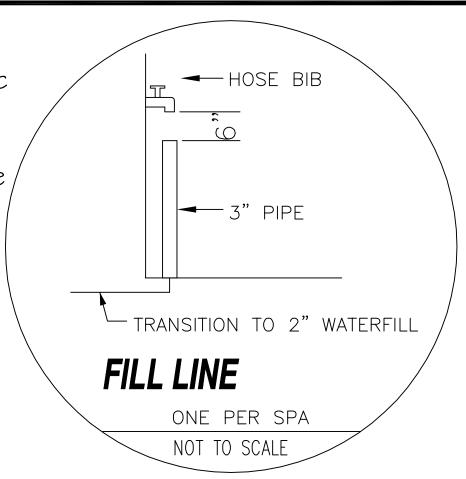
SCALE  $1 \frac{1}{2} = 1$ 4/9/2007 DATE

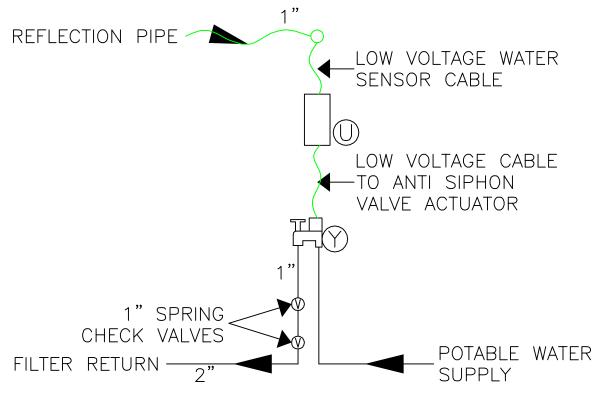
18" X 18" FRAME, 196 INCHES OPEN AREA, 918 GPM @ 1 1/2 FT/SEC

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## Note:

Conceptual schematic of spa equipment placement.Code and Mechanical compliance to be authorized by engineer.





ALL DIMENSIONS SUBJECT TO 1/4" TOLERANCES

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SIZE DWG TYPE

N/A

DATE

DWG NO.

6/20/2007

WATER FILL DETAIL PLUMBING DETAILS

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# BACK FLOW PREVENTOR Note: Conceptual schematic CONNECT TO WATER MAIN W/SHUT-OFF VALVE of spa equipment placement. Code and I-1/2" FRESH WATER SUPPLY Mechanical compliance PLACE LEVELOR ACTUATOR VALVE HERE to be authorized by engineer. 1-1/2" VALVE I" PIPE I-I/2" EFFLUENT LEVELOR CONTROL UNIT SENSOR UNIT FLOOR LEVEL SPA WATER LEVEL 2" REFLECTION PIPE FROM SPA

## WATER LEVEL CONTROL

N/A

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DWG TYPE SIZE H2O LEVEL CONTROL | PLUMBING DETAILS

DATE

6/20/2007

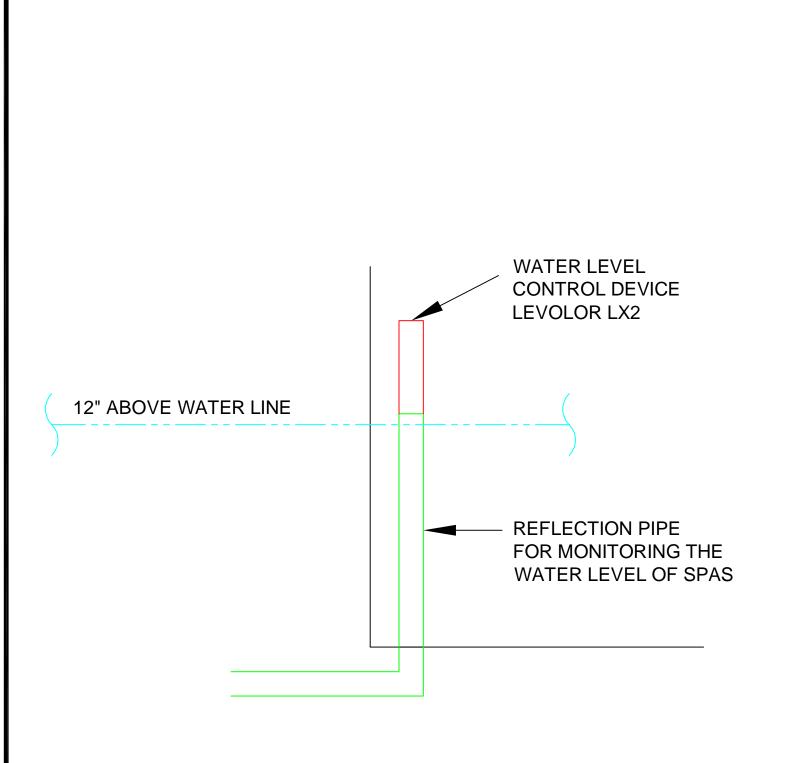
DWG NO.

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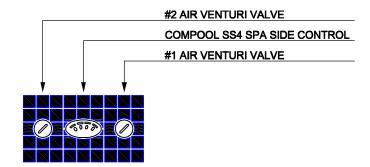
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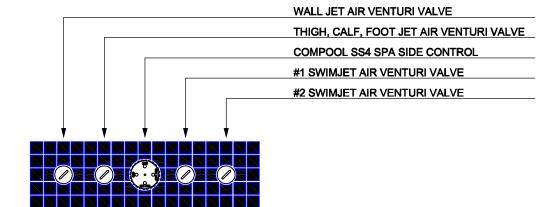
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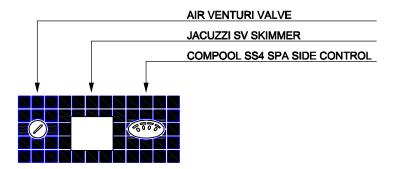
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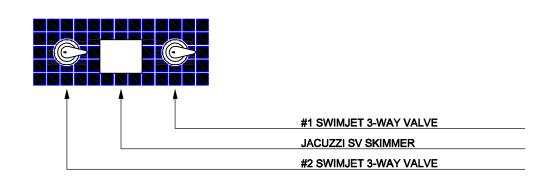
SCALE N/A DATE 4/9/2007

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A WL CONTROLS

DWG NO.
PLUMBING DETAILS

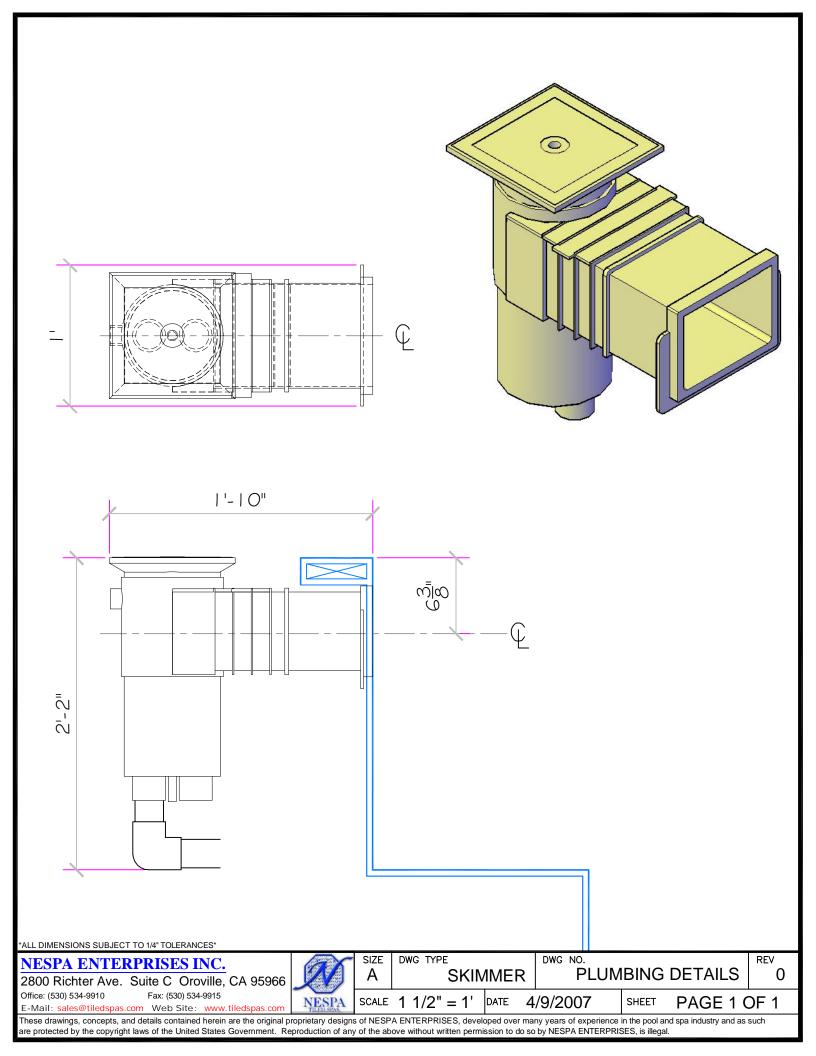
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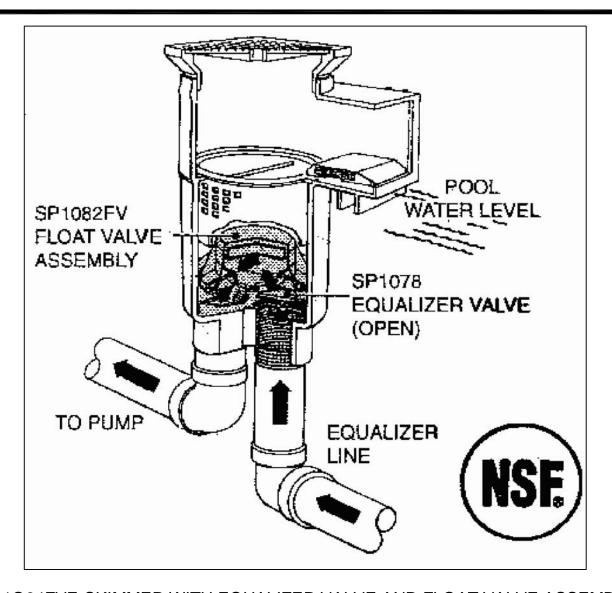
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DATE 4/9/2007

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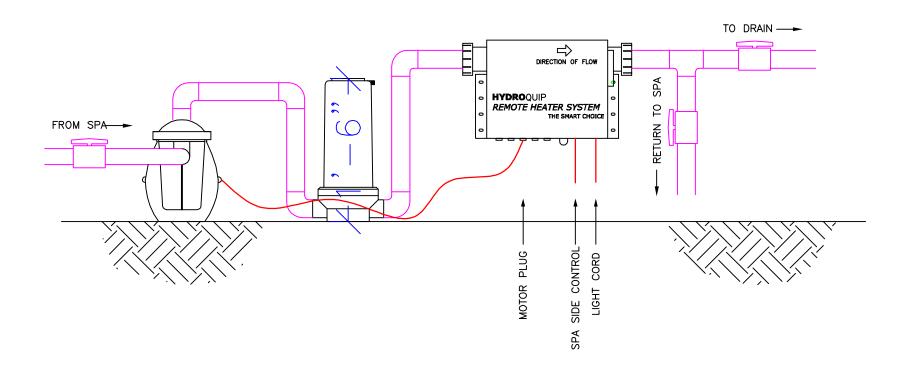
## SP1084FVE-SKIMMER WITH EQUALIZER VALVE AND FLOAT VALVE ASSEMBLY

A. EQUALIZER-Model SP1078 Equalizer Valve Assembly installs over front port, and is used in conjunction with the SP1082FV Float Valve Assembly. If water level drops below skimmer opening, or if skimmer flow is obstructed, the float will automatically snap shut and the equalizer valve will open. This diverts all flow to the pump from the equalizer line and prevents airlock in the pump- When the pump is shut off, and the water level condition is corrected, the float will rise and the equalizer valve will close, allowing normal skimming operation when the pump is restarted.

B. TO VACUUM Select one convenient skimmer and remove cover. Fill vacuum hose with water and insert onto SP1106 or SP1107 Skim-Vac (not supplied with skimmer) over basket vacuum-plate (not supplied with skimmer). Place Skim-Vac through skimmer opening and over skimmer basket. Turn circulating pump on and proceed with vacuuming. Throttle downflow from other skimmer(s) until desired suction is obtained through vacuum hose.

ALL DIMENSIONS SUBJECT TO 1/4" TOLERANCES\*

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2800 Richter Ave.	Suite C Oroville,	CA 95966		Α	SKIMI	MER	(2)	PLUIV	IBING	DETAILS	Ü
Office: (530) 534-9910	Fax: (530) 534-9915		MECDA	SCALE	N/A	DATE	4/9/	2007	SHEET	PAGE 1 (	OF 1
F-Mail: sales@tiledspas.c	com Web Site: www.t	tiledsnas com	THEOLA	JOALE	IN/A	אראטן	4/3/	<b>2</b> 00 <i>1</i>	SHEET	FAGEI	ノロー



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A Electric Heater Section

DATE 4/9/2007

DWG NO.
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PVC SCHEDULE 40						
Pipe Size	6 FPS	8 FPS	10 FPS			
1 "	16	22	27			
1 1/2"	38	51	64			
2"	63	84	105			
2 1/2"	90	119	149			
3"	138	184	230			
4"	238	317	397			
6"	540	720	900			

All SPA SUCTION FLOW RATES MAXIMUM FOR PIPE SIZE

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A Pipe Schedule

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